




GROUND FLOOR PLAN

SHOWING STRUCTURE OVER

SCALE 1:50

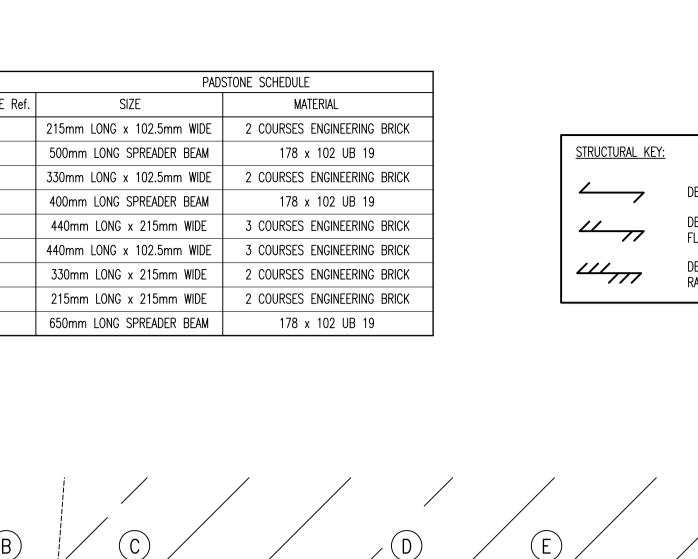

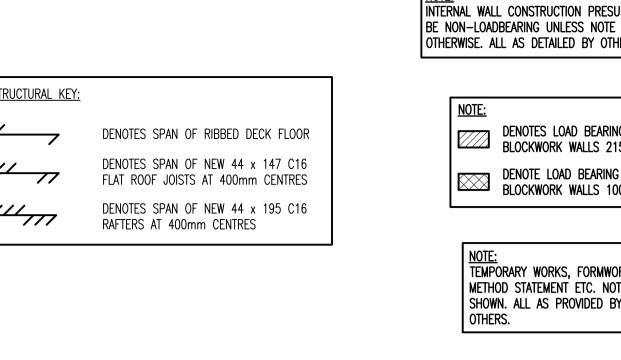

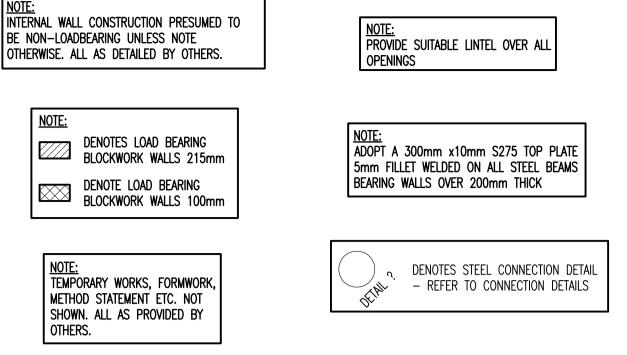

 (M)

23. ALL STEELWORK ENCASED IN MASONRY SHALL RECIEVE TWO COATS OF BITUMINOUS PAINT BUILD UP OF 75 MICRONS.

25. ALL STEELWORK LOCATED BELOW GROUND LEVEL TO HAVE

75mm MIN. CONCRETE COVER.

2. THIS DRAWING IS TO BE READ IN CONJUNCTION WITH ALL OTHER 24. ALL STEELWORK IS TO BE COATED AS PER THE SPECIFICATION.

ENGINEERS AND ARCHITECTS DRAWINGS AND THE SPECIFICATION.

1. DO NOT SCALE THIS DRAWING, ALL DIMENSIONS ARE IN MILLIMETRES UNLESS NOTED OTHERWISE. ANY DISCREPANCIES ARE

3. ALL WORK IS TO BE TO THE SATISFACTION OF THE ENGINEER AND LOCAL AUTHORITY BUILDING CONTROL.

TO BE RECORDED AND REPORTED TO THE ENGINEERS IMMEDIATELY.

4. THE CONTRACTOR IS RESPONSIBLE FOR AND MUST TAKE ALL NECESSARY PRECAUTIONS TO ENSURE THE STABILITY OF THE WORKS AT ALL TIMES DURING CONSTRUCTION.

5. ALL WORKMANSHIP AND MATERIALS ARE TO BE TO CURRENT BRITISH STANDARDS OR EUROCODES. ALL CONSTRUCTION PRODUCTS AND STRUCTURAL STEELWORK SHOULD BE CE MARKED IN ACCORDANCE WITH CURRENT LEGISLATION.

6. ALL SERVICES ARE TO BE LOCATED AND PROTECTED AS NECESSARY BY THE CONTRACTOR PRIOR TO THE COMMENCEMENT OF THE WORKS.

7. ANY EXISTING DETAILS WHICH ARE SHOWN ON THIS DRAWING ARE FOR GUIDANCE ONLY AND ARE TO BE CHECKED ON SITE BY THE CONTRACTOR. ANY VARIATIONS ARE TO BE RECORDED AND REPORTED TO THE ENGINEER IMMEDIATELY.

8. ALL REINFORCED CONCRETE IS TO BE CAST UPON 50mm MIN. THICKNESS OF CONCRETE BLINDING OF THE FOLLOWING MIX UNLESS NOTED OTHERWISE:

- DESIGNATED MIX GEN1
- STANDARD MIX ST1/ST2

9. COVER TO REINFORCING BARS TO BE 40mm EACH FACE IF SHUTTERED OR 75mm IF CAST AGAINST VIRGIN GROUND UNLESS NOTED OTHERWISE.

10. REINFORCING BARS ARE TO BE TO BS 4449: 2005, BS 4483: 2005 AND BS 8666: 2005 AS APPLICABLE.

11. ALL REINFORCING BARS ARE TO BE SECURELY WIRED TOGETHER & LOCATED WITH SUITABLY FIXED STOOLS, SPACERS, COVER BLOCKS ETC. THESE ITEMS ARE NOT SCHEDULED.

12. MINIMUM LAP TO REINFORCING BARS TO BE 40 x THE BAR DIAMETER.

13. MINIMUM LAP TO MESH REINFORCEMENT TO BE 600mm.

14. REINFORCED CONCRETE TO BE DESIGNATED MIX RC35 IN ACCORDANCE WITH THE REQUIREMENTS OF BS 8500 USING 20mm NOMINAL SIZED AGGREGATE. DESIGN SULPHATE CLASS DS-3 & ACEC AC-3 UNLESS NOTED OTHERWISE.

15. ALL STRUCTURAL CONCRETE SHALL BE ADEQUATELY COMPACTED USING A POKER TYPE VIBRATOR WITHIN SUITABLE SHUTTERING/FORMWORK.

16. THE CONTRACTOR IS RESPONSIBLE FOR THE DESIGN, SUPPORT AND ERECTION OF ANY SHUTTERING/FORMWORK REQUIRED.

17. FLEXIBLE PROTECTION IS TO BE PROVIDED AROUND ALL SERVICES WITH 50mm COMPRESSIBLE WRAPPING MATERIAL.


18. ALL TIMBER IS TO BE TREATED IN ACCORDANCE WITH CURRENT REGULATIONS AND STANDARDS.

19. ALL TIMBER FIXINGS ARE TO GALVANISED UNLESS NOTED

20. ALL TIMBER TO BE STRESS GRADED.

21. ALL STEELWORK BEARING ONTO PADSTONES TO BE BEDDED ON 1:2 CEMENT/SAND MORTAR.

22. ALL PADSTONES TO BE ENGINEERING BRICK UNLESS NOTED OTHERWISE.

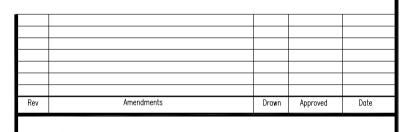

SHAYA ASSOCIATES AN ENGINEERING, ARCHITECTURAL

& SURVEYING PRACTICE 62 PRINCES PARK AVENUE GOLDERS GREEN, LONDON NW11 OJT Tel: 020 8455 2693 Fax: 020 8201 9720


email: mms@shayaassociates.co.uk


2A THE GROVE

Drawing Title GROUND FLOOR PLAN STRUCTURE OVER

Designed by Checked by Approved by AS SHOWN MARCH 2015

Drawing No. L15/011/01 - 503

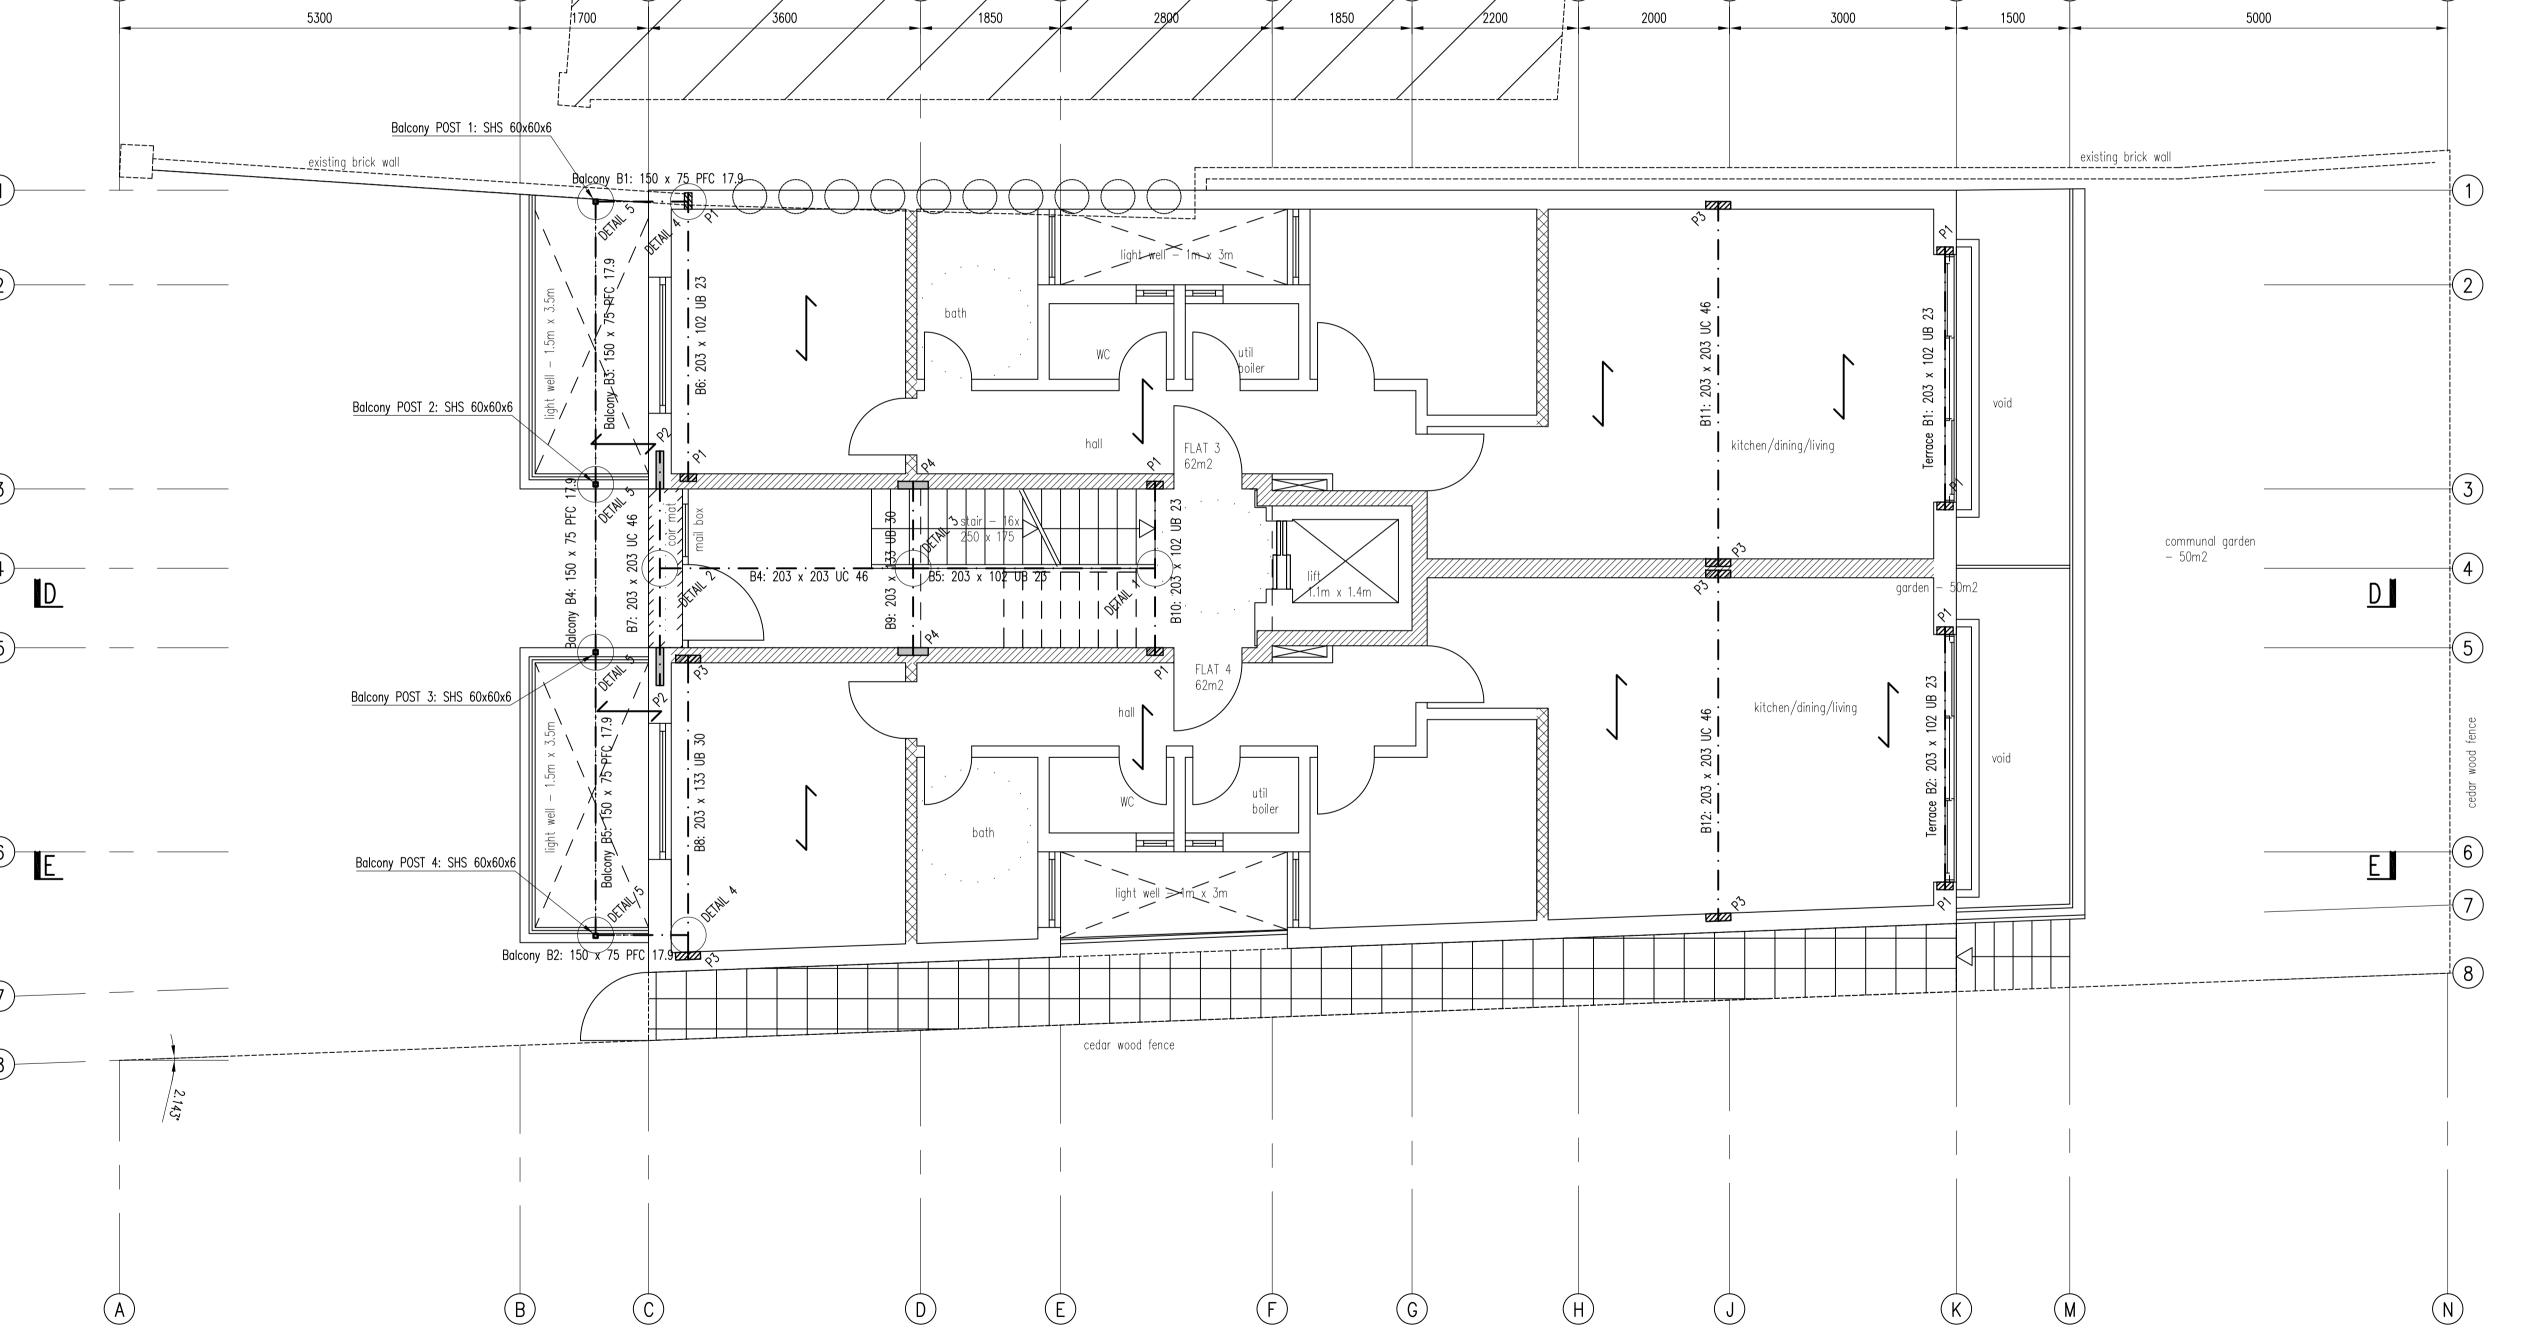

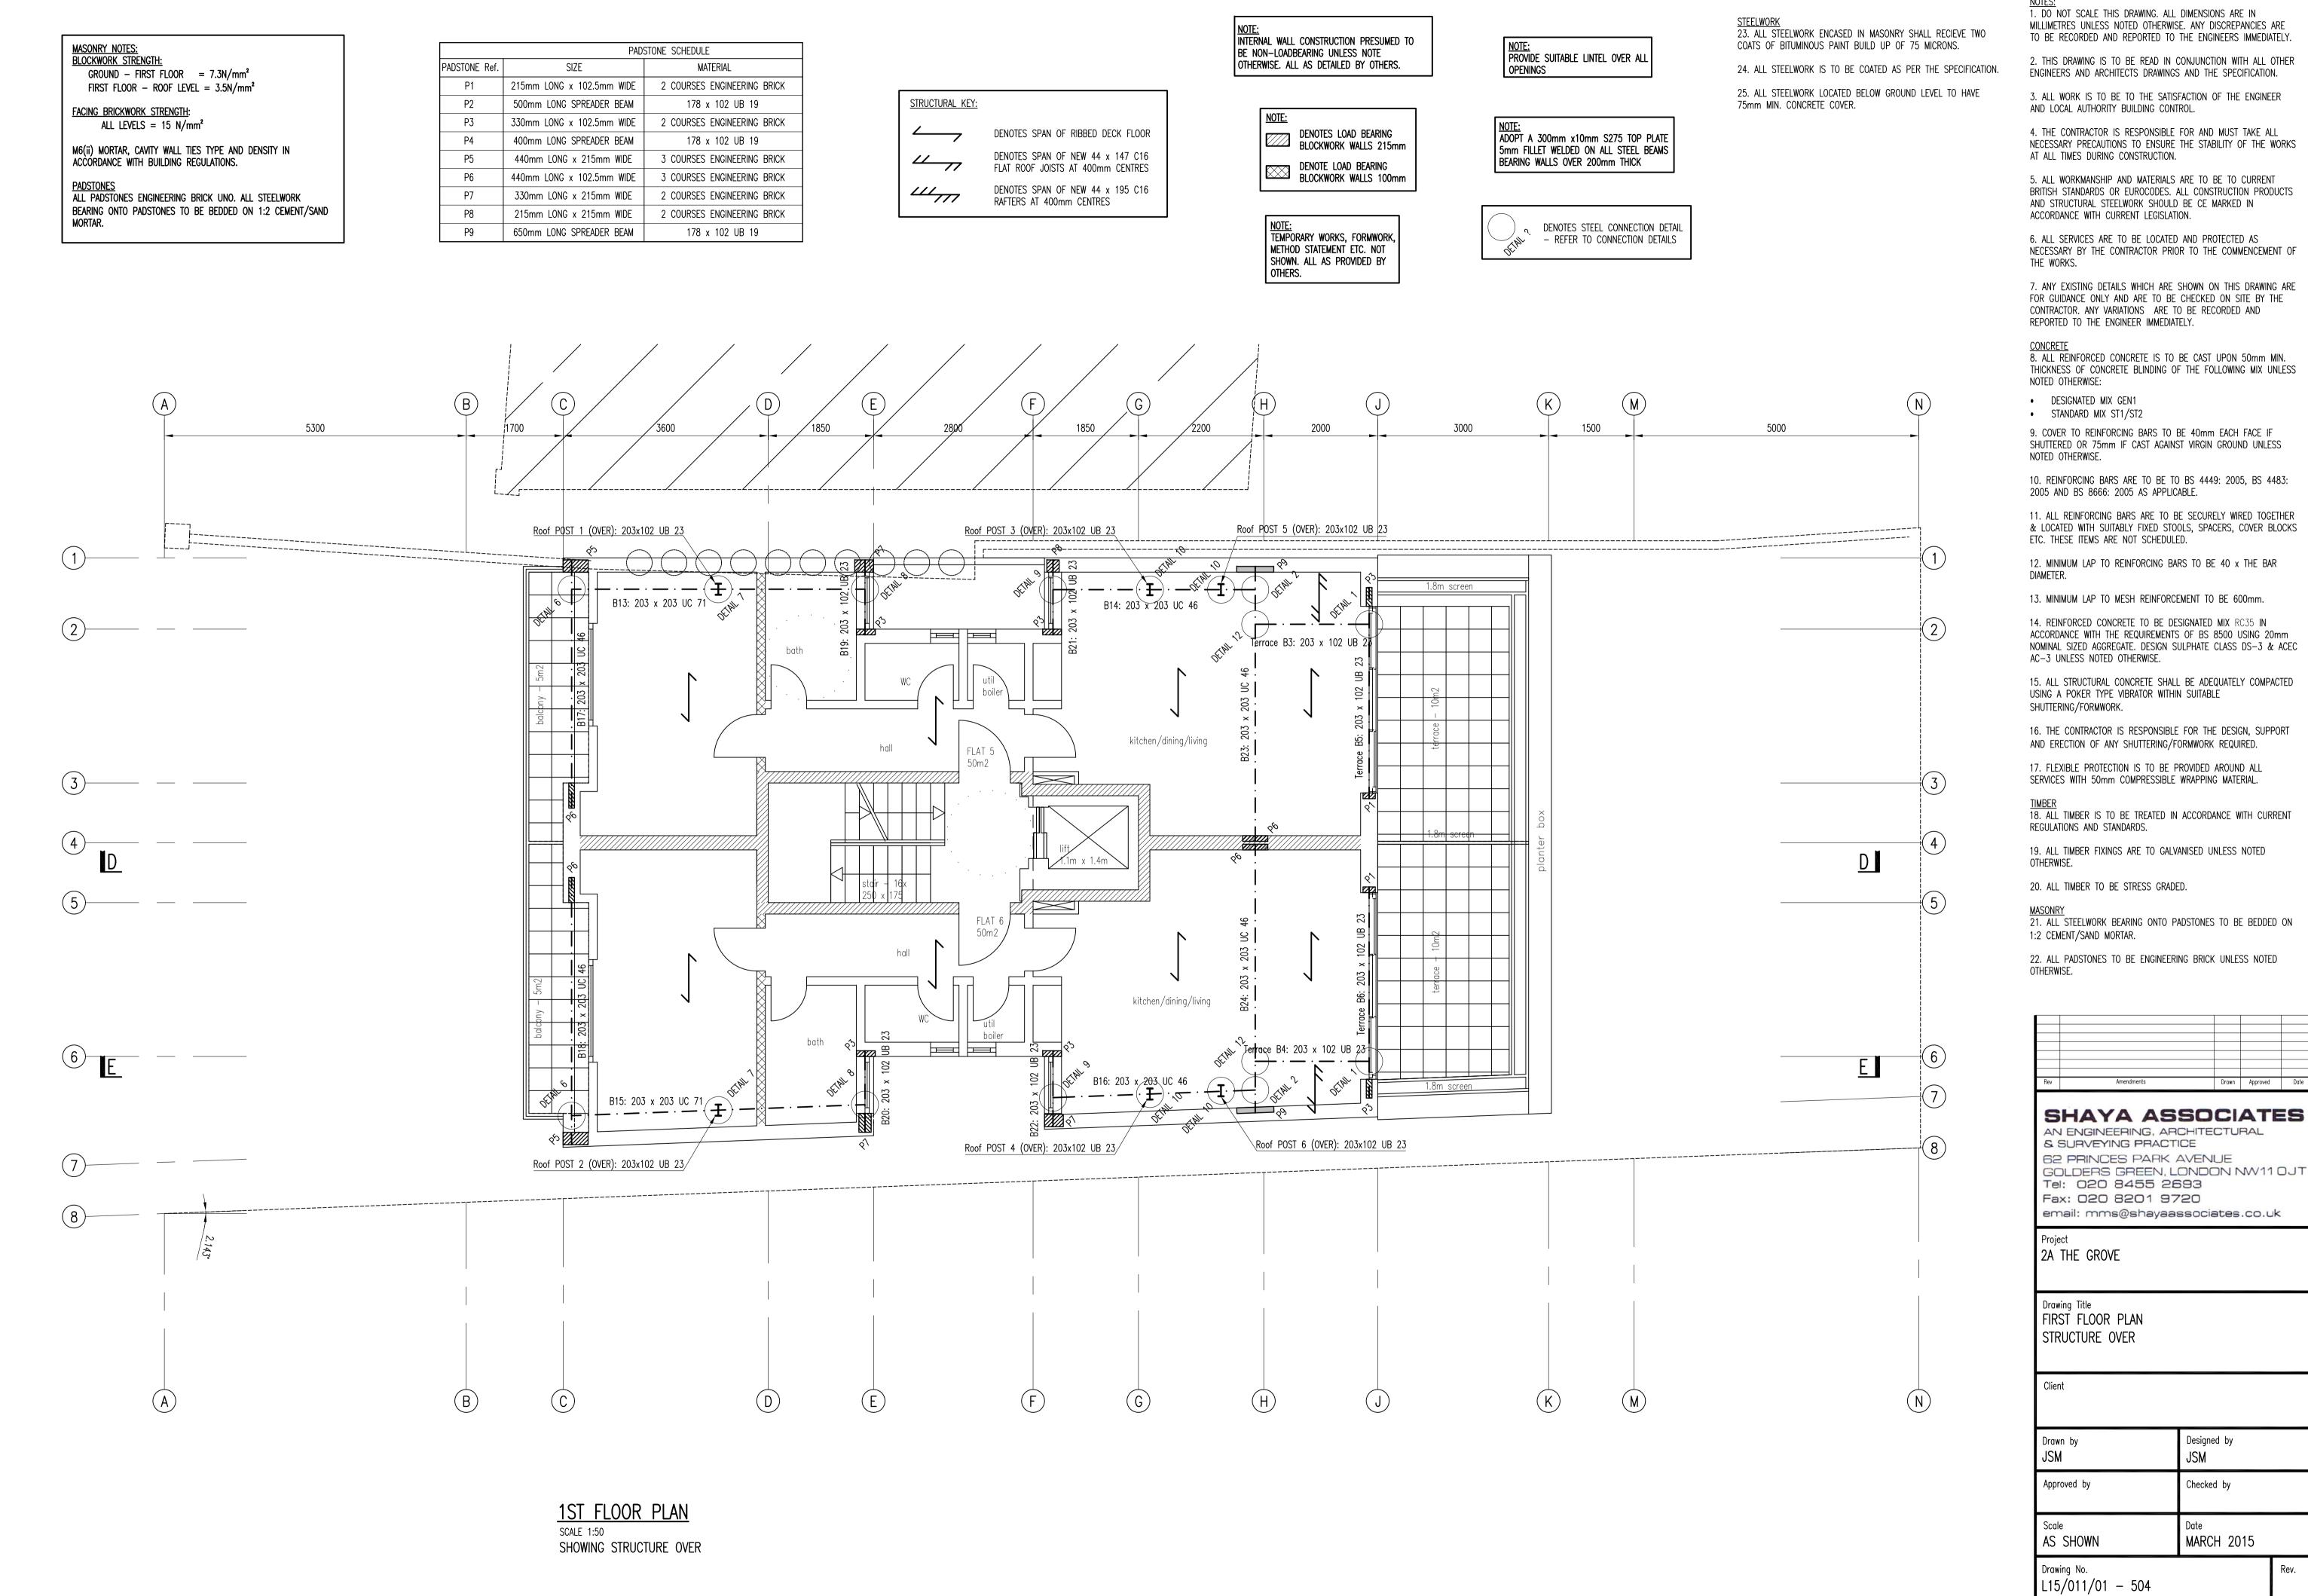

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ENGINEERS AND ARCHITECTS DRAWINGS AND THE SPECIFICATION.

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ACCORDANCE WITH THE REQUIREMENTS OF BS 8500 USING 20mm NOMINAL SIZED AGGREGATE. DESIGN SULPHATE CLASS DS-3 & ACEC


AND ERECTION OF ANY SHUTTERING/FORMWORK REQUIRED.

SERVICES WITH 50mm COMPRESSIBLE WRAPPING MATERIAL.

18. ALL TIMBER IS TO BE TREATED IN ACCORDANCE WITH CURRENT

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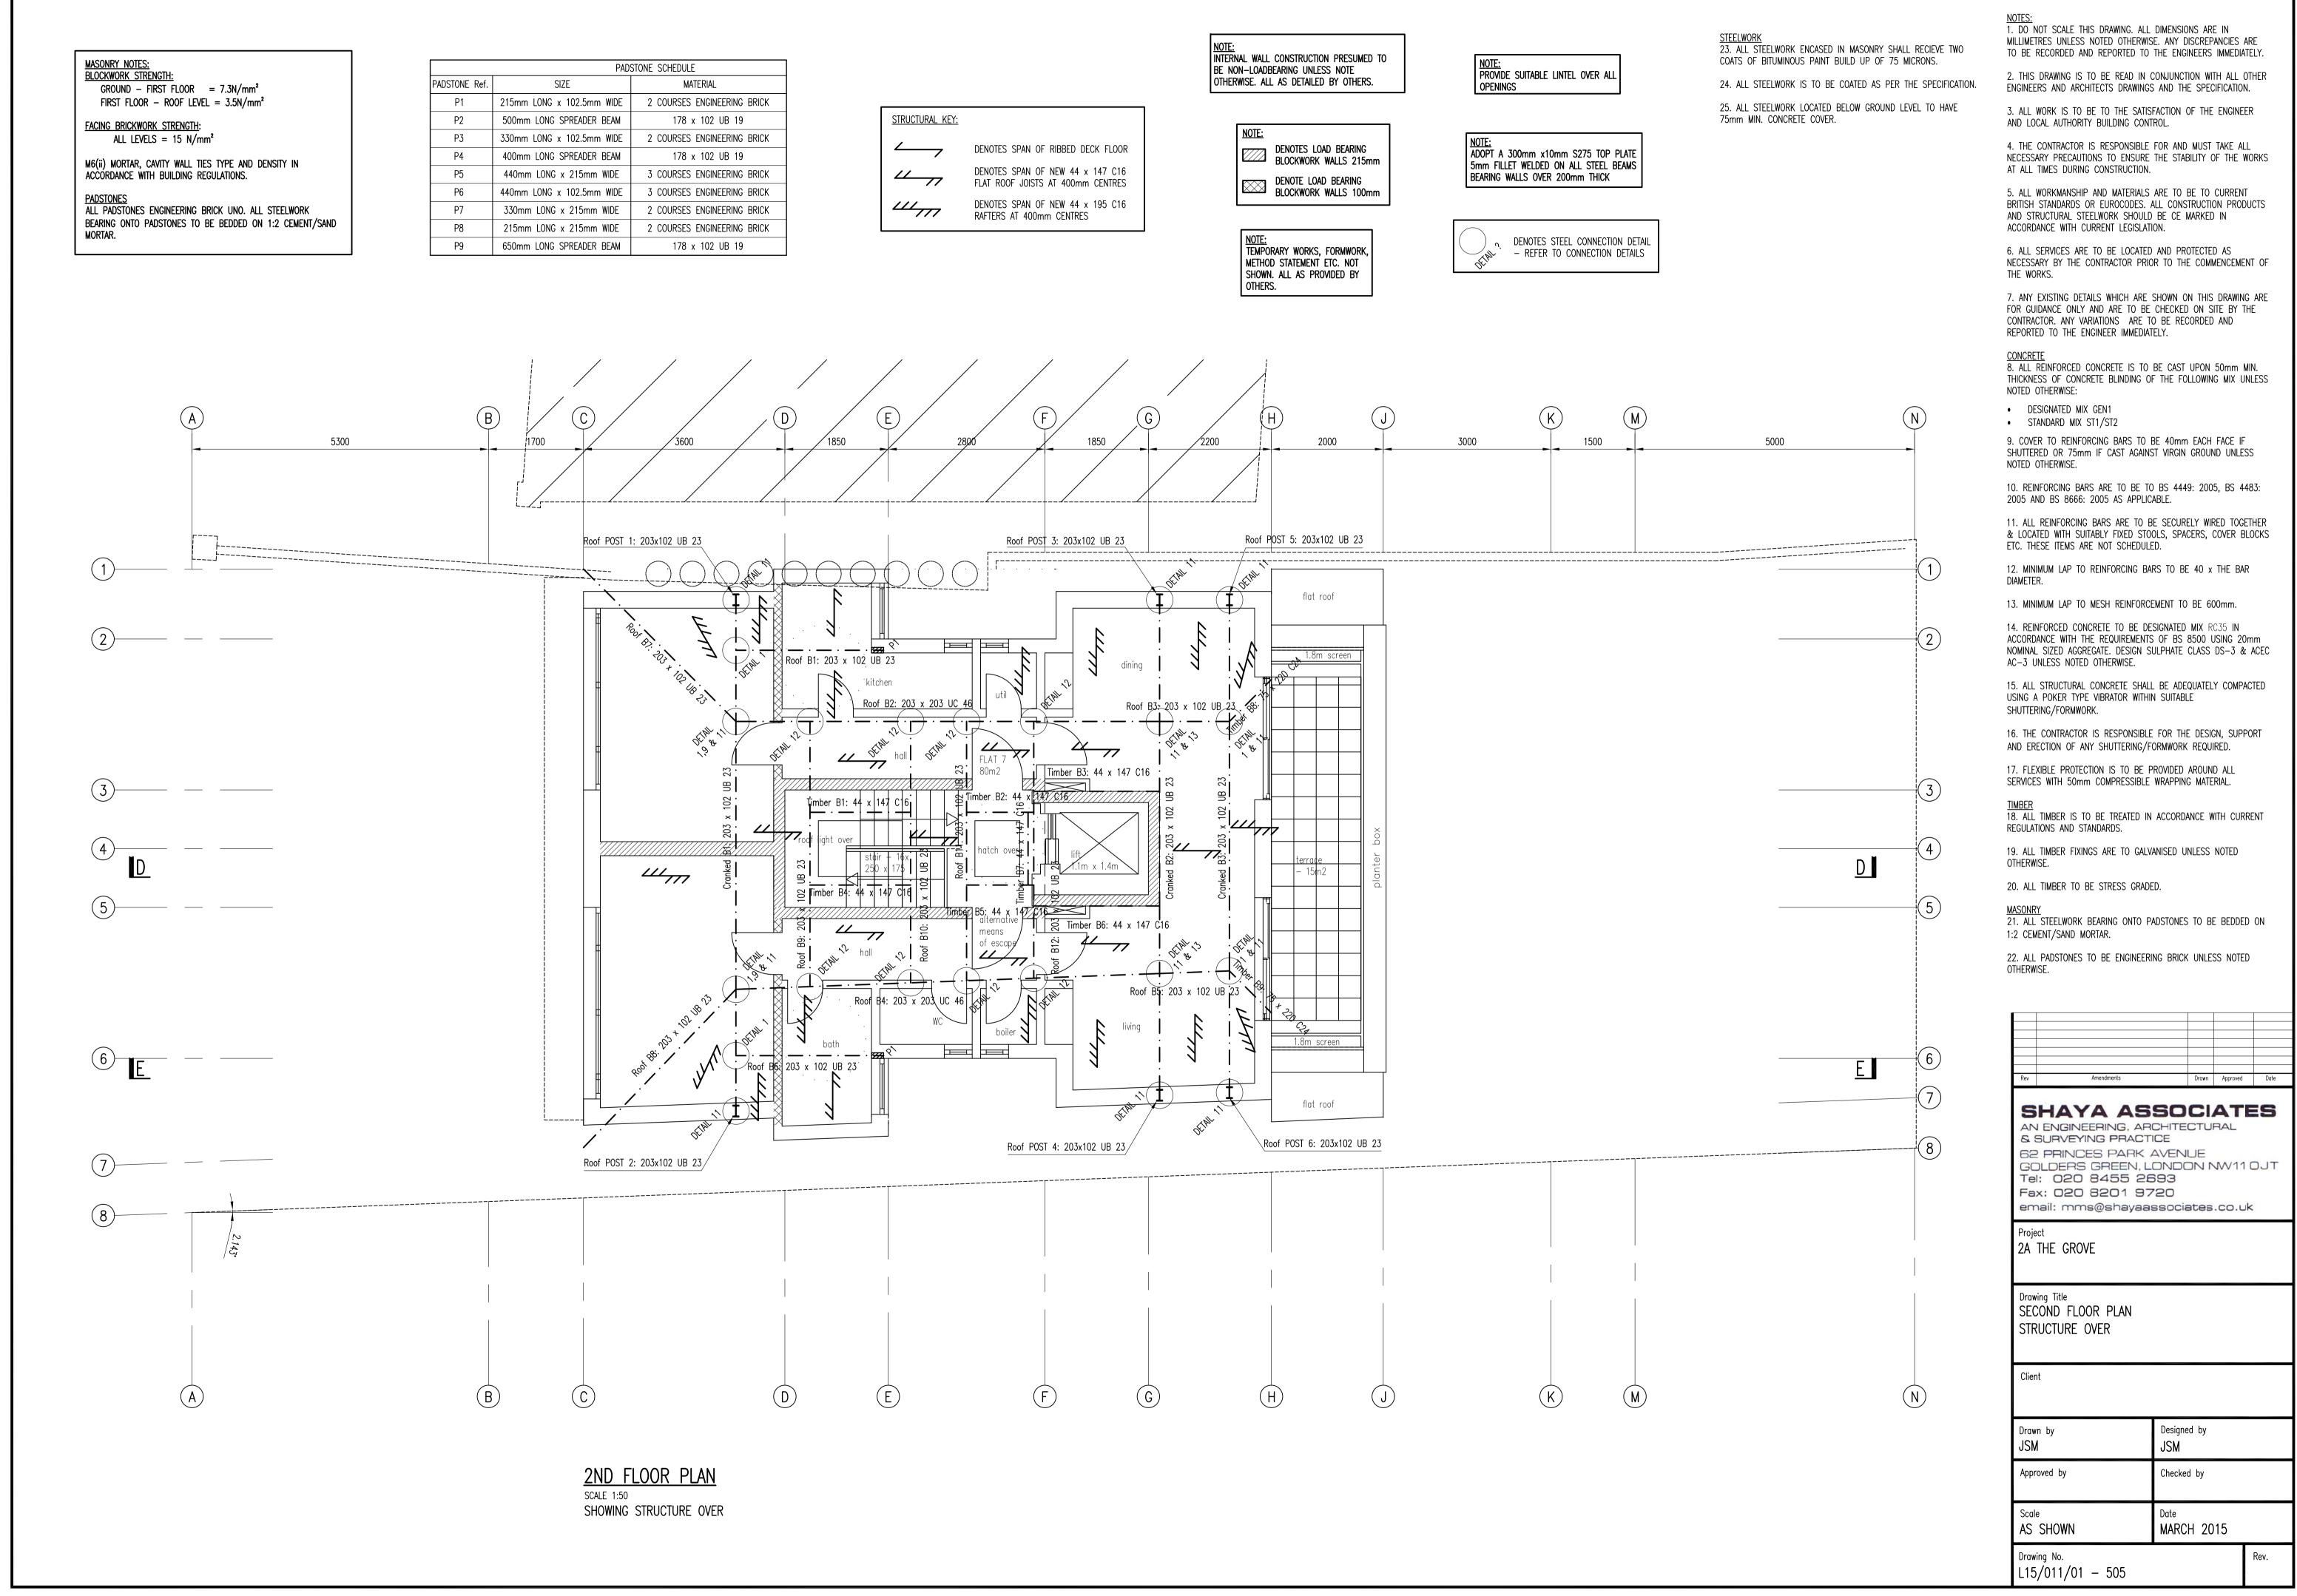
22. ALL PADSTONES TO BE ENGINEERING BRICK UNLESS NOTED

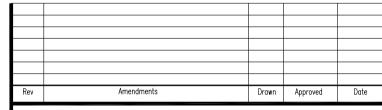



62 PRINCES PARK AVENUE GOLDERS GREEN, LONDON NW11 OJT


email: mms@shayaassociates.co.uk

MARCH 2015




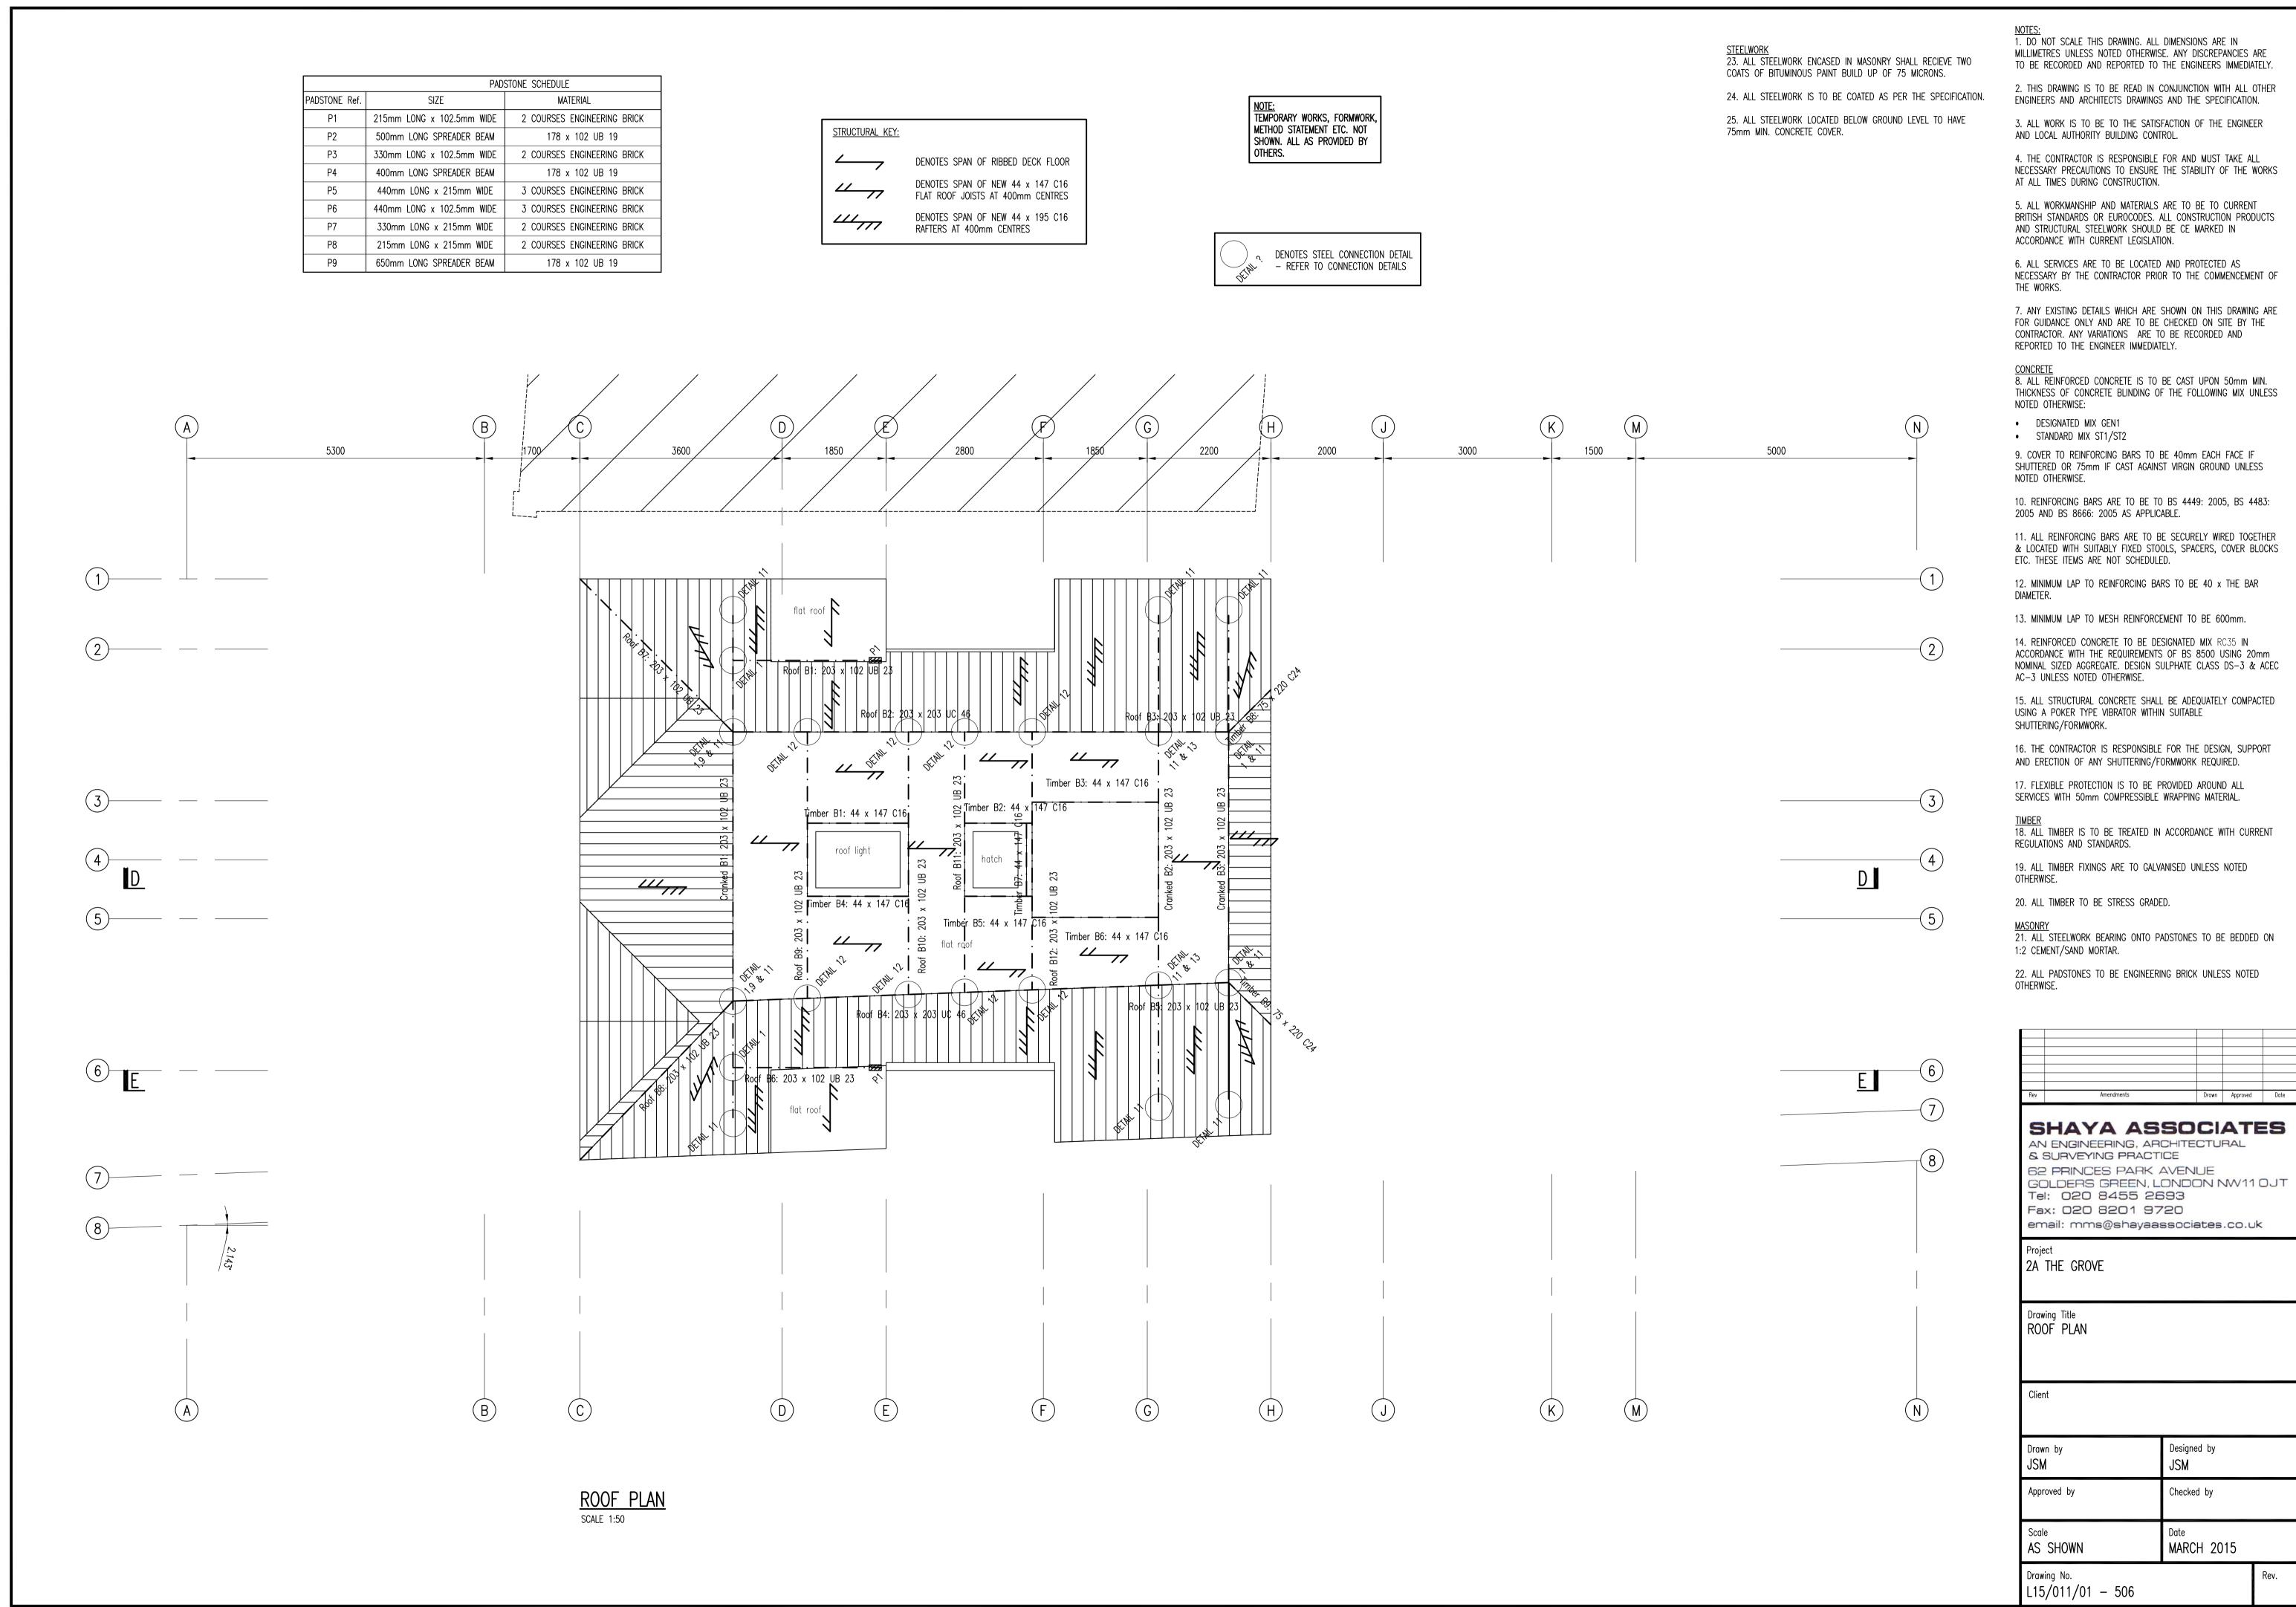

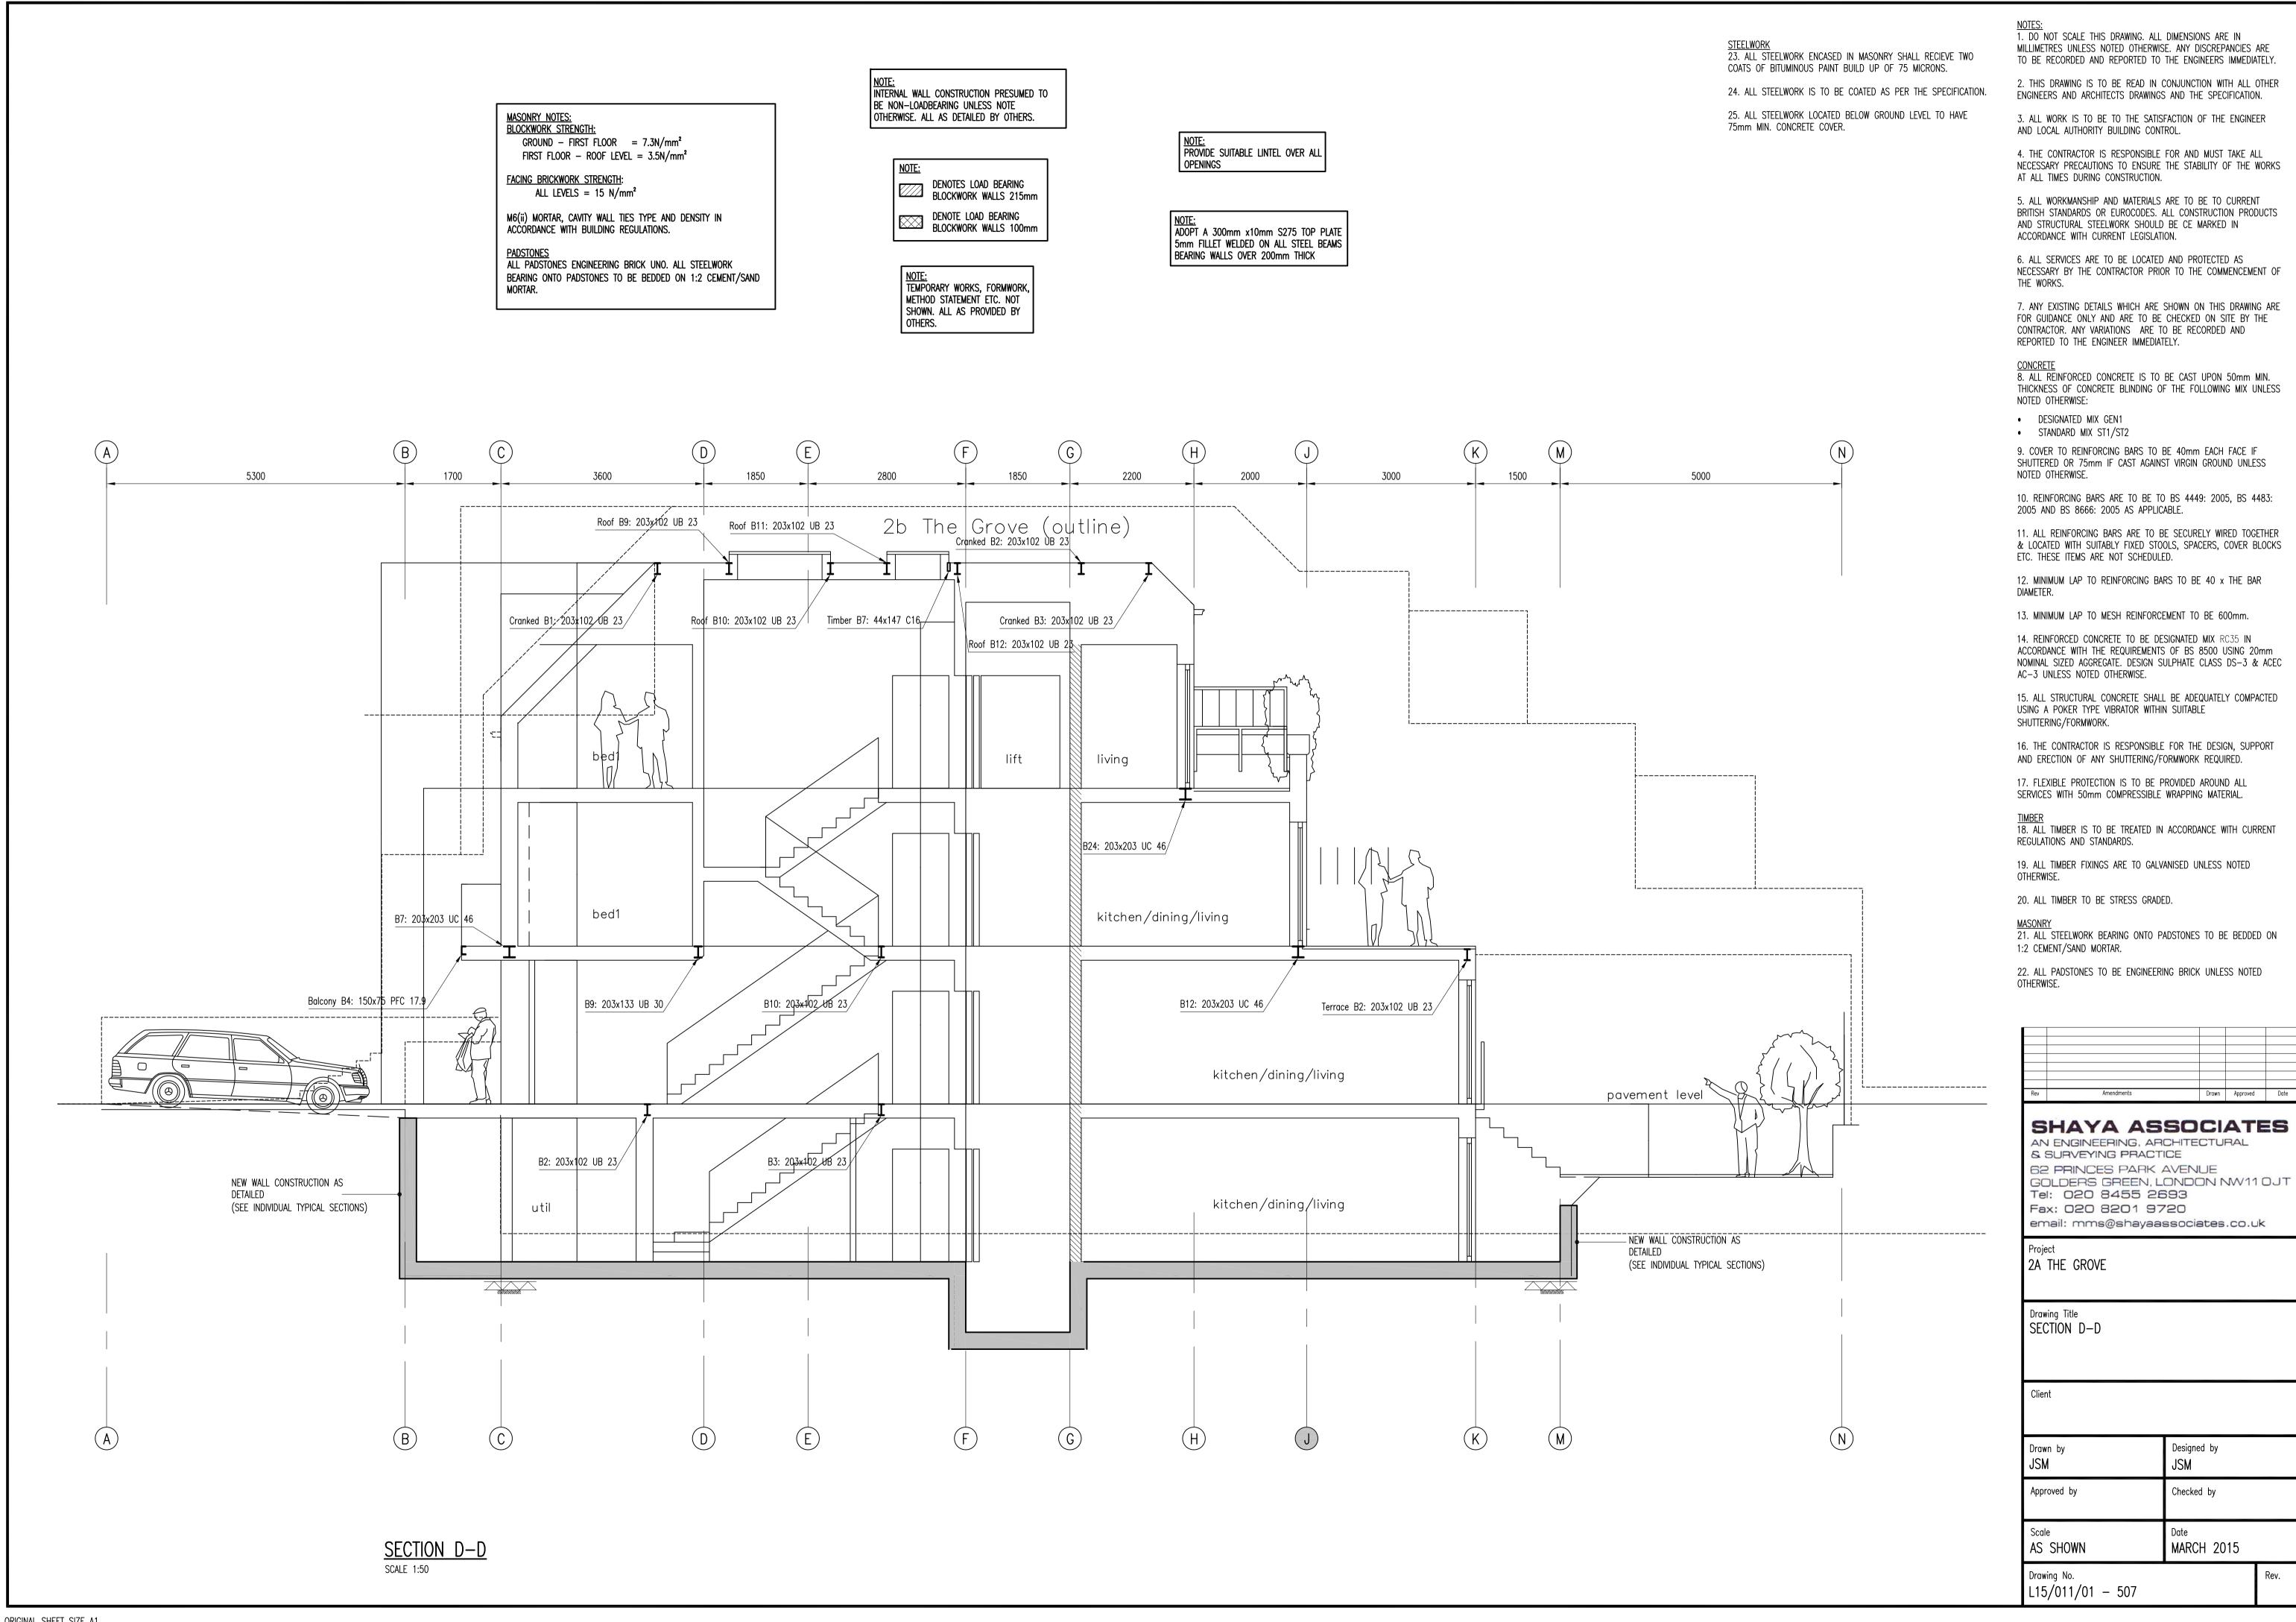


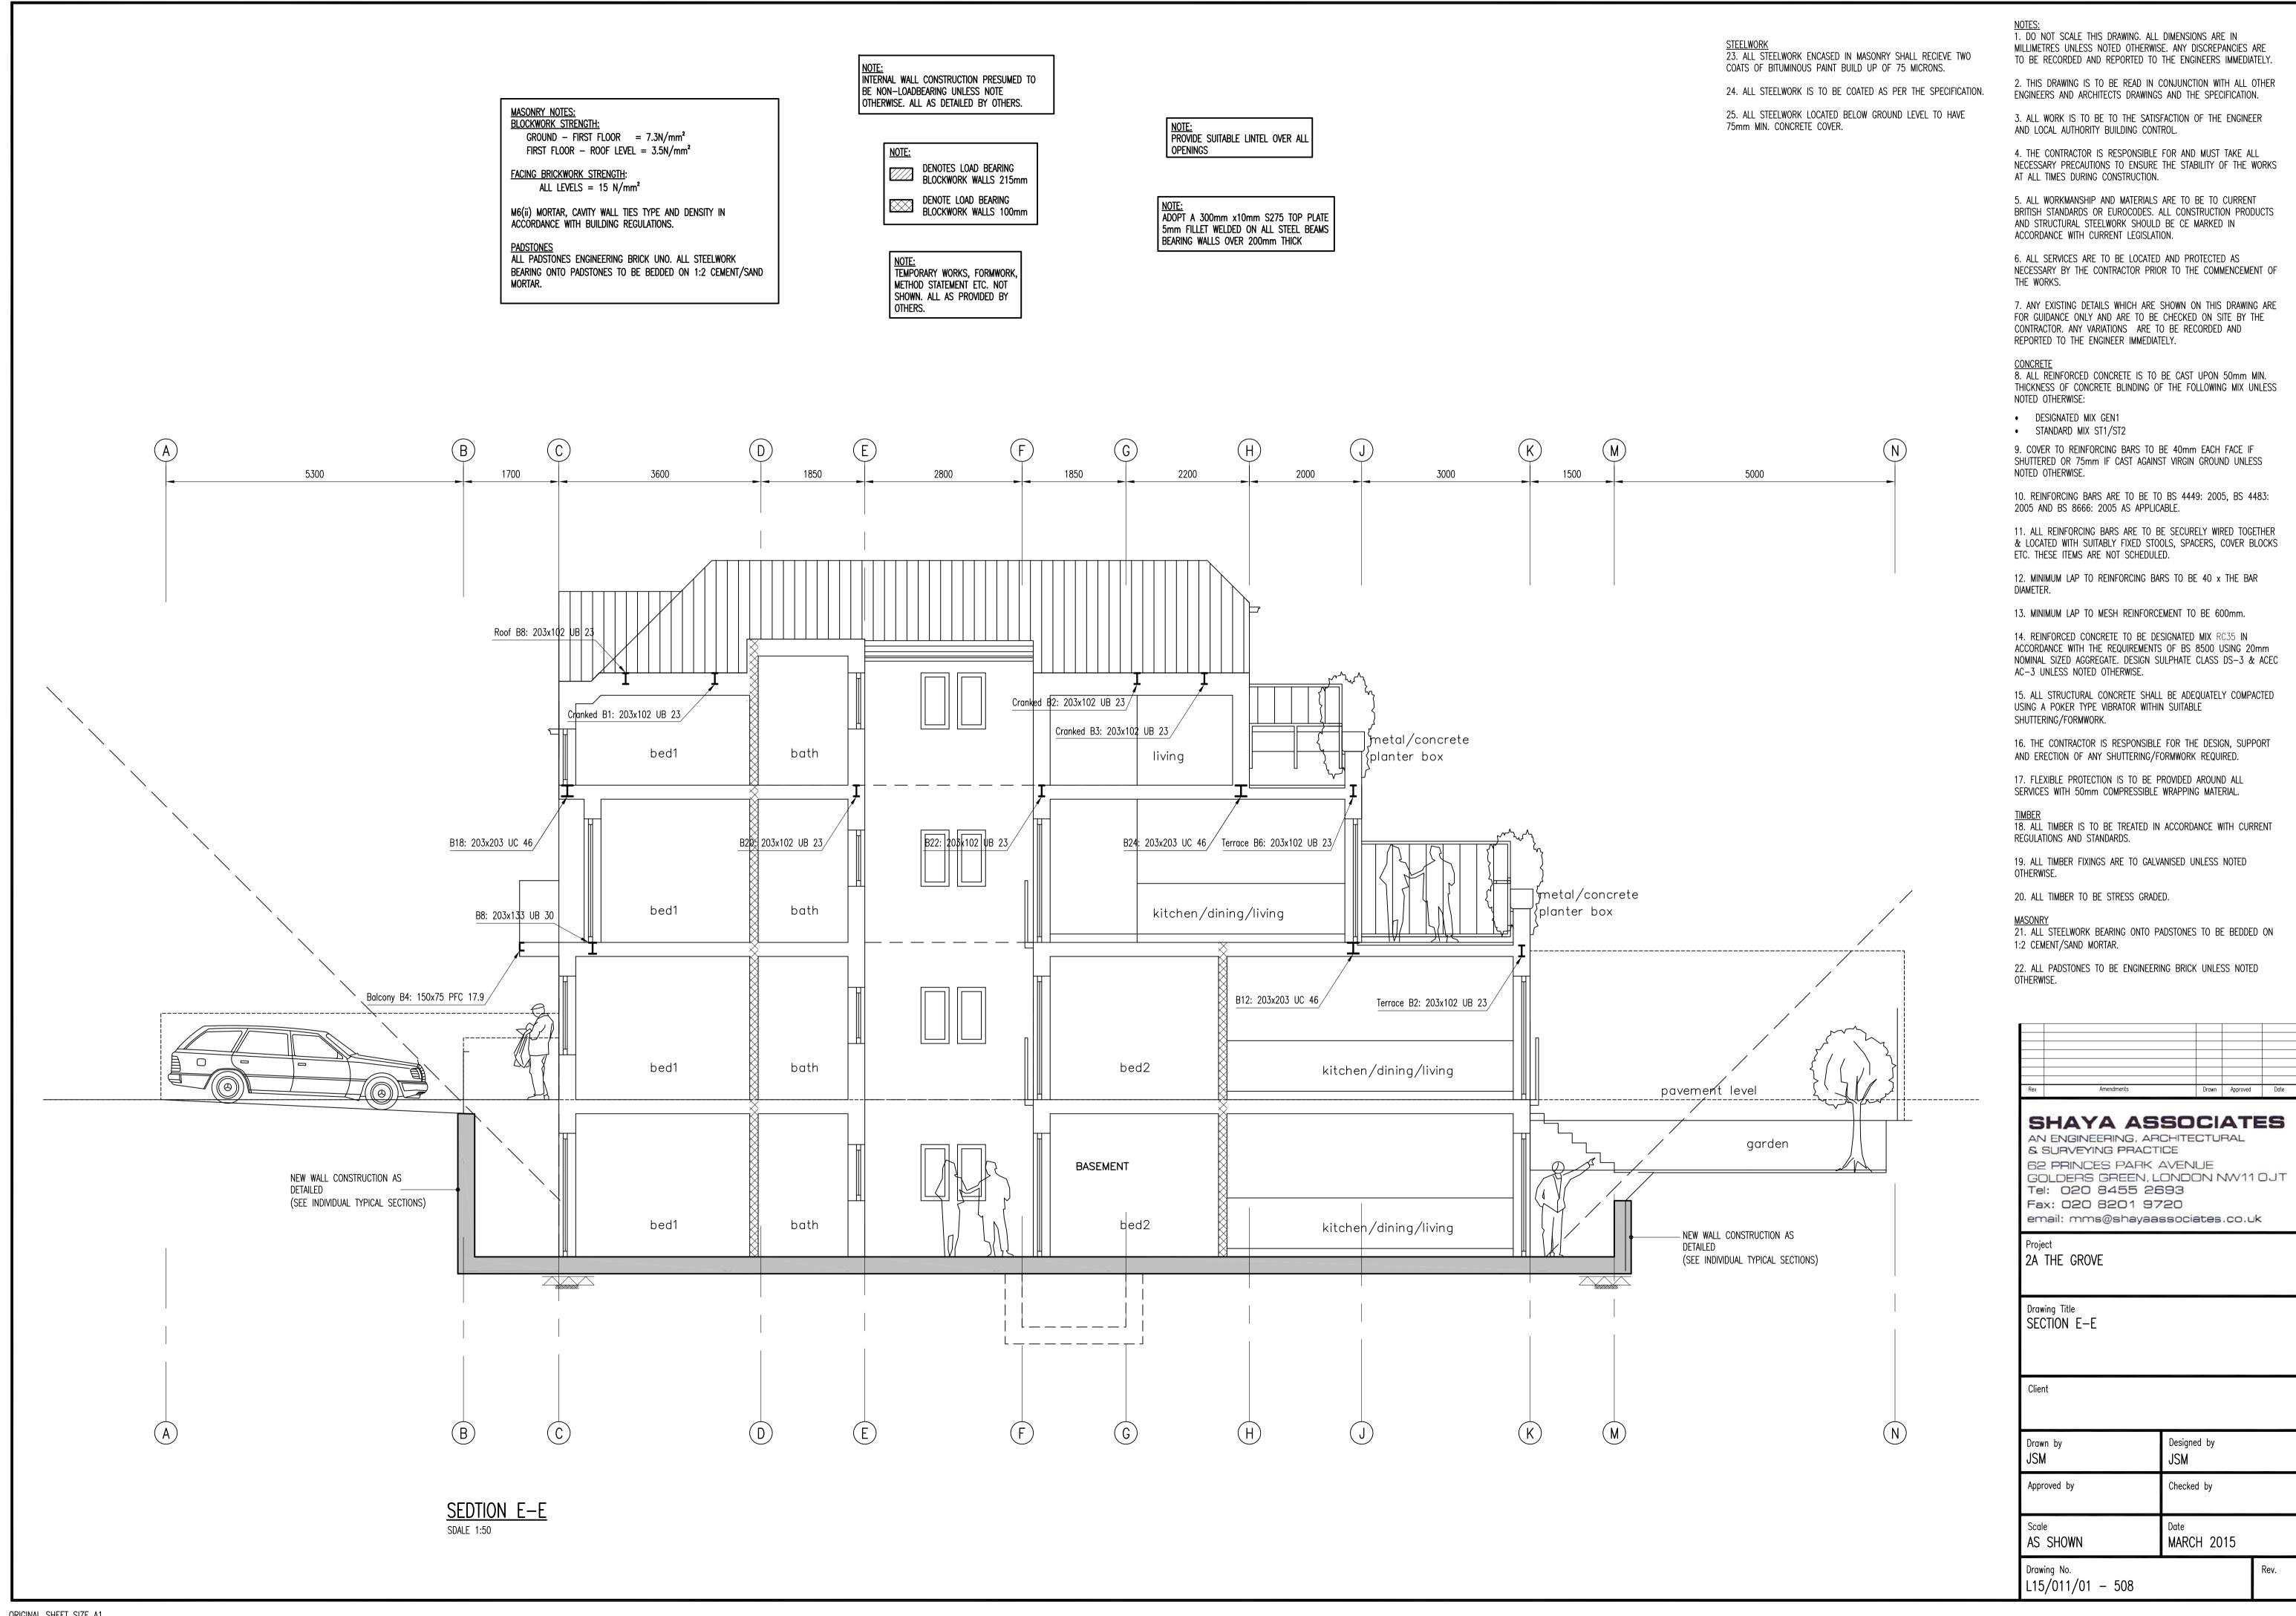


ORIGINAL SHEET SIZE A1

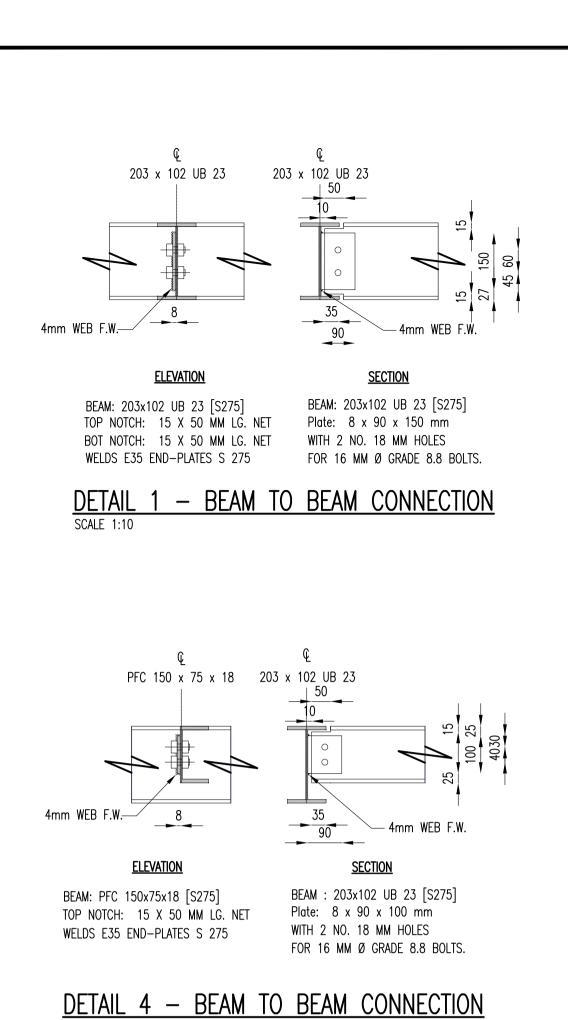




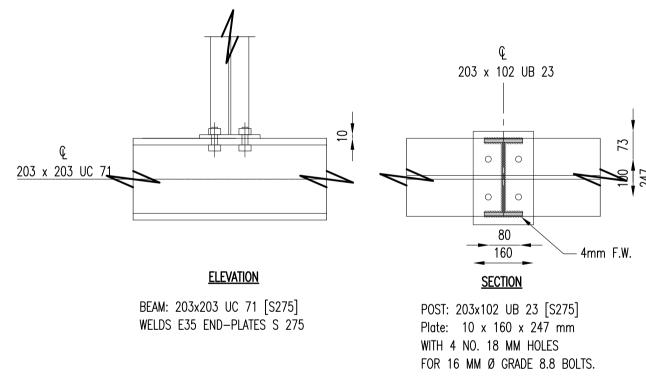

DETAIL 7 - POST TO BEAM CONNECTION

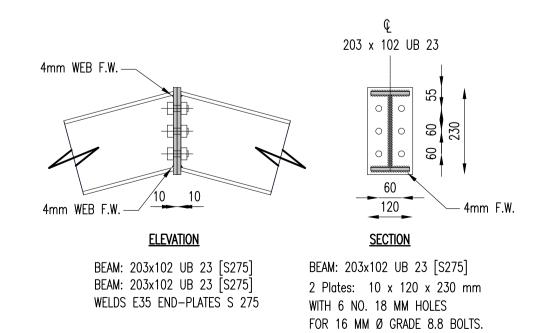

DETAIL 11 - CRANKED BEAM CONNECTION

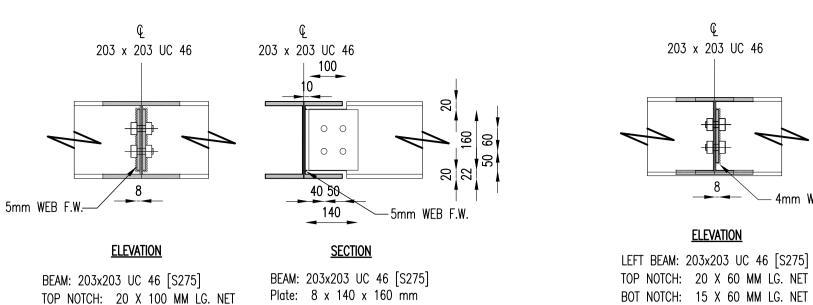

<u>DETAIL 2 — BEAM TO BEAM CONNECTION</u>


BOT NOTCH: 20 X 100 MM LG. NET

SCALE 1:10

WELDS E35 END-PLATES S 275


WITH 4 NO. 18 MM HOLES

FOR 16 MM Ø GRADE 8.8 BOLTS.

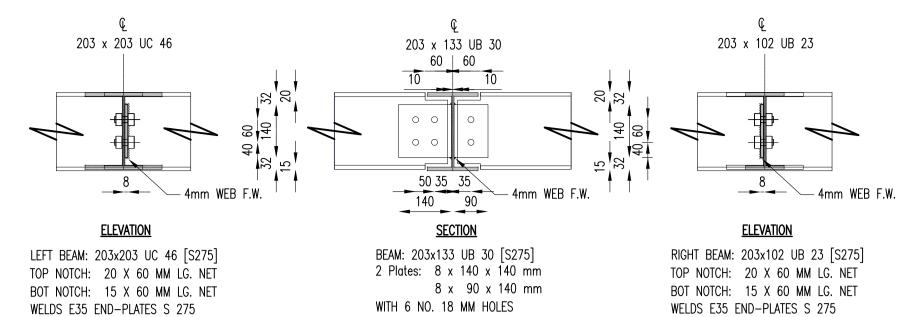


DETAIL 3 - BEAMS TO BEAM CONNECTION SCALE 1:10


FOR 16 MM Ø GRADE 8.8 BOLTS.

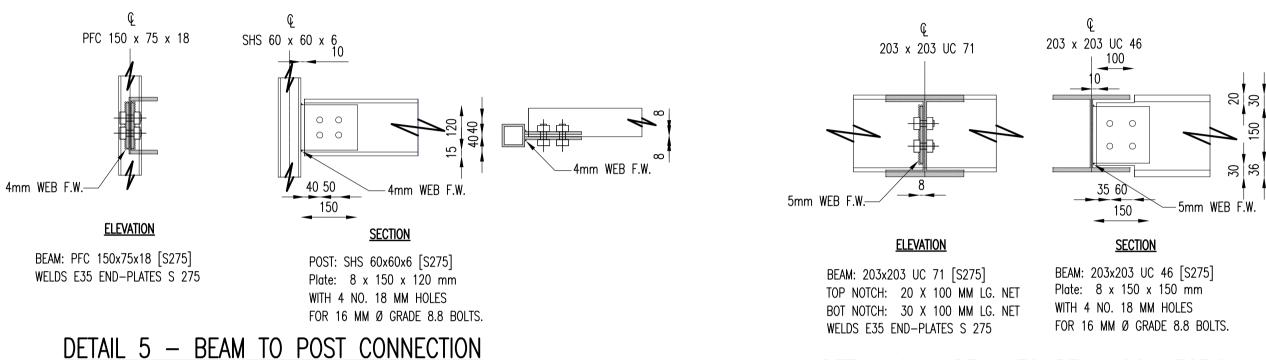

<u>6 - BEAM TO BEAM CONNECTION</u>

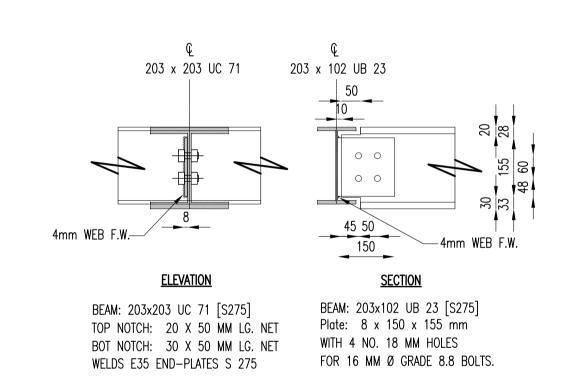


<u> 8 — BEAM TO BEAM CONNECTION</u>

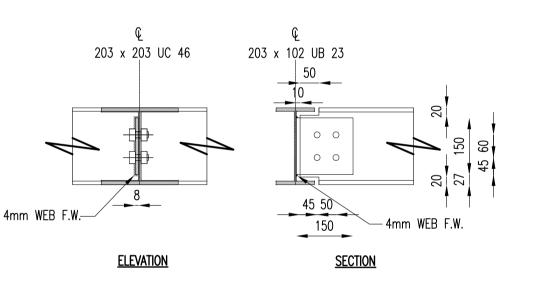


BEAM: 203x203 UB 23 [S275] BEAM: 203x203 UC 46 [S275] Plate: 8 x 150 x 150 mm TOP NOTCH: 20 X 50 MM LG. NET WITH 4 NO. 18 MM HOLES BOT NOTCH: 20 X 50 MM LG. NET FOR 16 MM Ø GRADE 8.8 BOLTS. WELDS E35 END-PLATES S 275


DETAIL 9 - BEAM TO BEAM CONNECTION

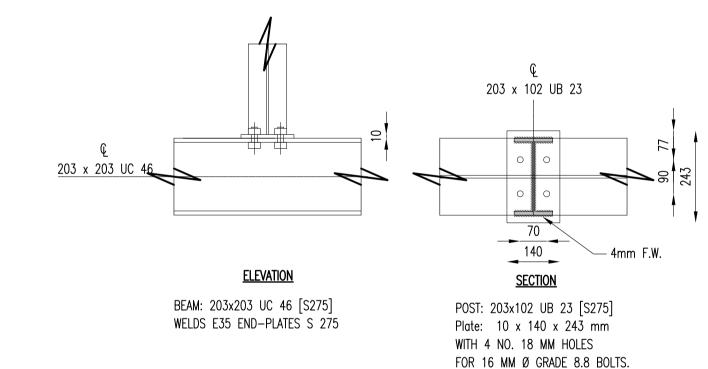

DETAIL 10 - POST TO BEAM CONNECTION

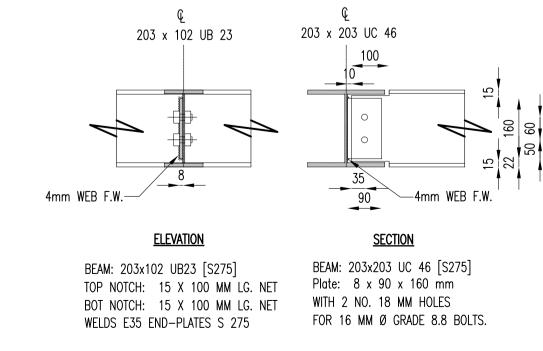



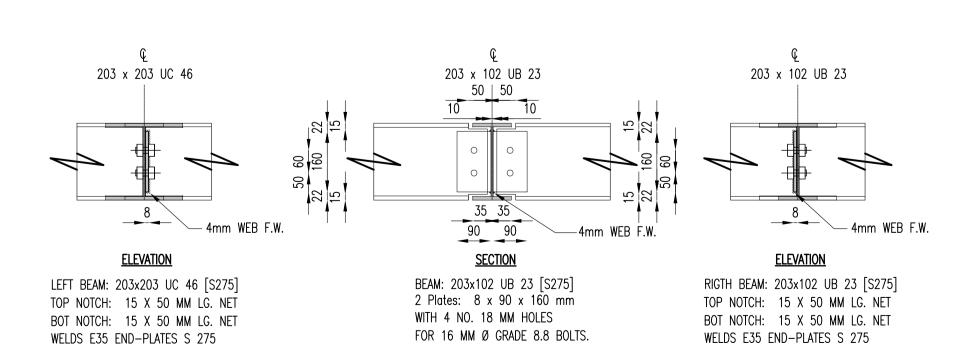

DETAIL 13 - BEAMS TO BEAM CONNECTION

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75mm MIN. CONCRETE COVER.

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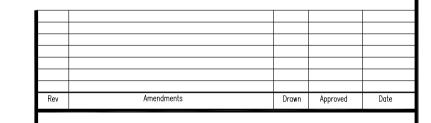
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SHAYA ASSOCIATES

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email: mms@shayaassociates.co.uk

2A THE GROVE

Drawing Title CONNECTION DETAILS

Designed by Drawn by Approved by Checked by MARCH 2015 AS SHOWN

Drawing No. L15/011/01 - 509

ORIGINAL SHEET SIZE A1

